



# ALAMEDA AVENUE SIDEWALKS EXTENSION PROJECT CYPRESS POINT AVE TO EMERSON STREET

TIB NO. C-P-130(002)-1 NOVEMBER 2025

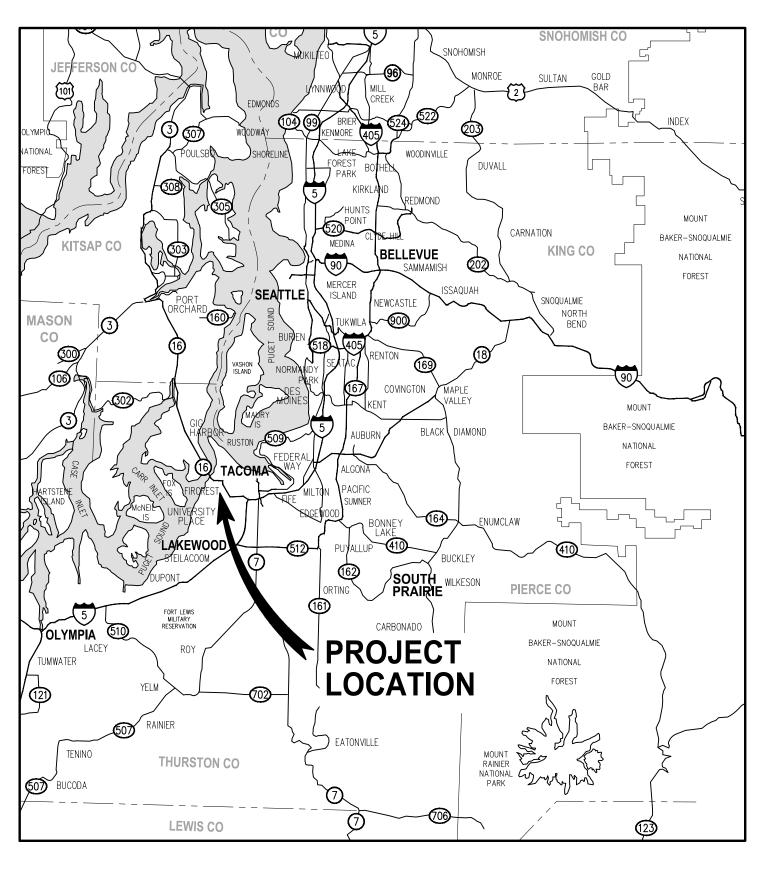

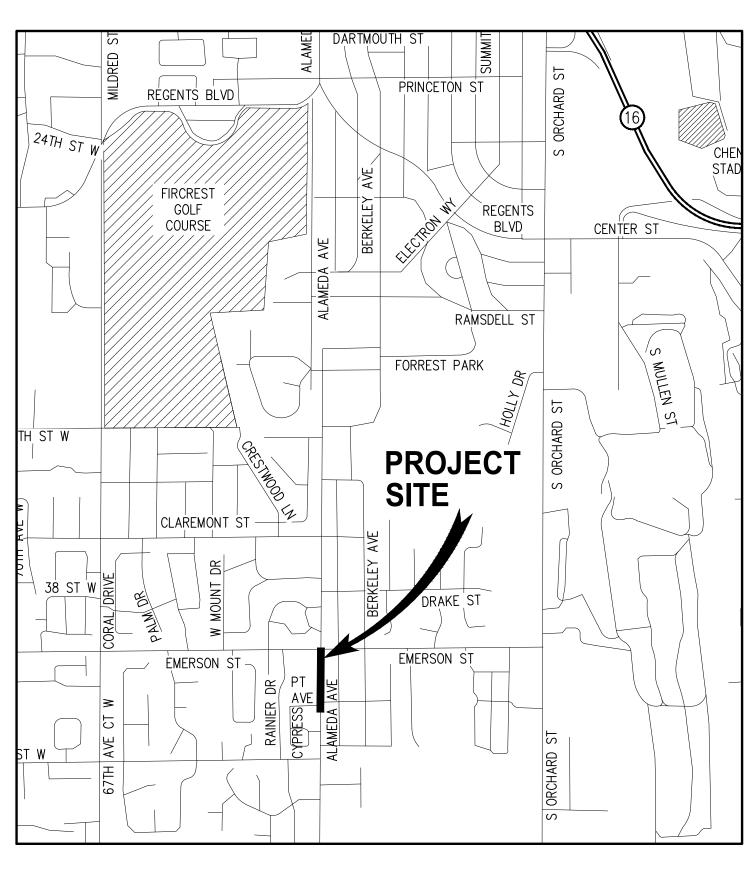

CITY OFFICIALS						
	DAVID M. VIAFORE					
	SHANNON REYNOLDS (MAYOR)					
	BRETT L. WITTNER					
COUNCIL MEMBER	KAREN MAUER-SMITH					
	HUNTER T. GEORGE					
	NIKKI BUFFORD (MAYOR PRO-TEMPORE)					
	JIM ANDREWS					
CITY MANAGER	DAWN MASKO					
PUBLIC WORKS DIRECTOR	TYLER BEMIS					
UTILITY FOREMAN	JEFF DAVIS					

DRAWING INDEX		
TITLE	SHEET	DESCRIPTION
GENERAL	1 2	COVER LEGEND, ABBREVIATIONS, ALIGNMENT & SURVEY CONTROL
TYPICAL SECTIONS & DETAILS	3	TYPICAL SECTIONS
SIDEWALK & STORMWATER PLAN & PROFILES	4 5	STA 0+00 TO STA 4+20 STA 4+20 TO STA 7+50
DRIVEWAY PLAN & PROFILES	6 7	D1 & D2 D3, D4 & D5
STANDARD PLANS & DETAILS	8-9	STANDARD PLANS & DETAILS






CALL 2 DAYS BEFORE YOU DIG 811

APPROVED	
BY: Tyler Bemis	11/10/2025
PUBLIC WORKS DIRECTOR	DATE:

NO.	DATE	BY	APPR.	REVISIONS	Approved By	9FIR010400COV.dwg		
							FILENAME	
							HH	11/2025
					ENGINEERING MANAGER	DATE	DESIGNED BY	DATE
							HH	11/2025
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							DPY	11/2025
					PROJECT ENGINEER	DATE	CHECKED BY	DATE






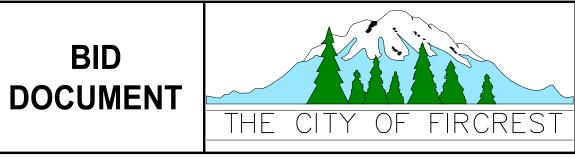

CITY OF FIRCREST	
ALAMEDA AVENUE SIDEWALKS EXTENSION	
CYPRESS POINT AVE TO EMERSON STREET	
<b>-</b>	_

		CO/	/ER				
•	PROJ. No.	9FIR010400	SHT _	1	OF _	9	_

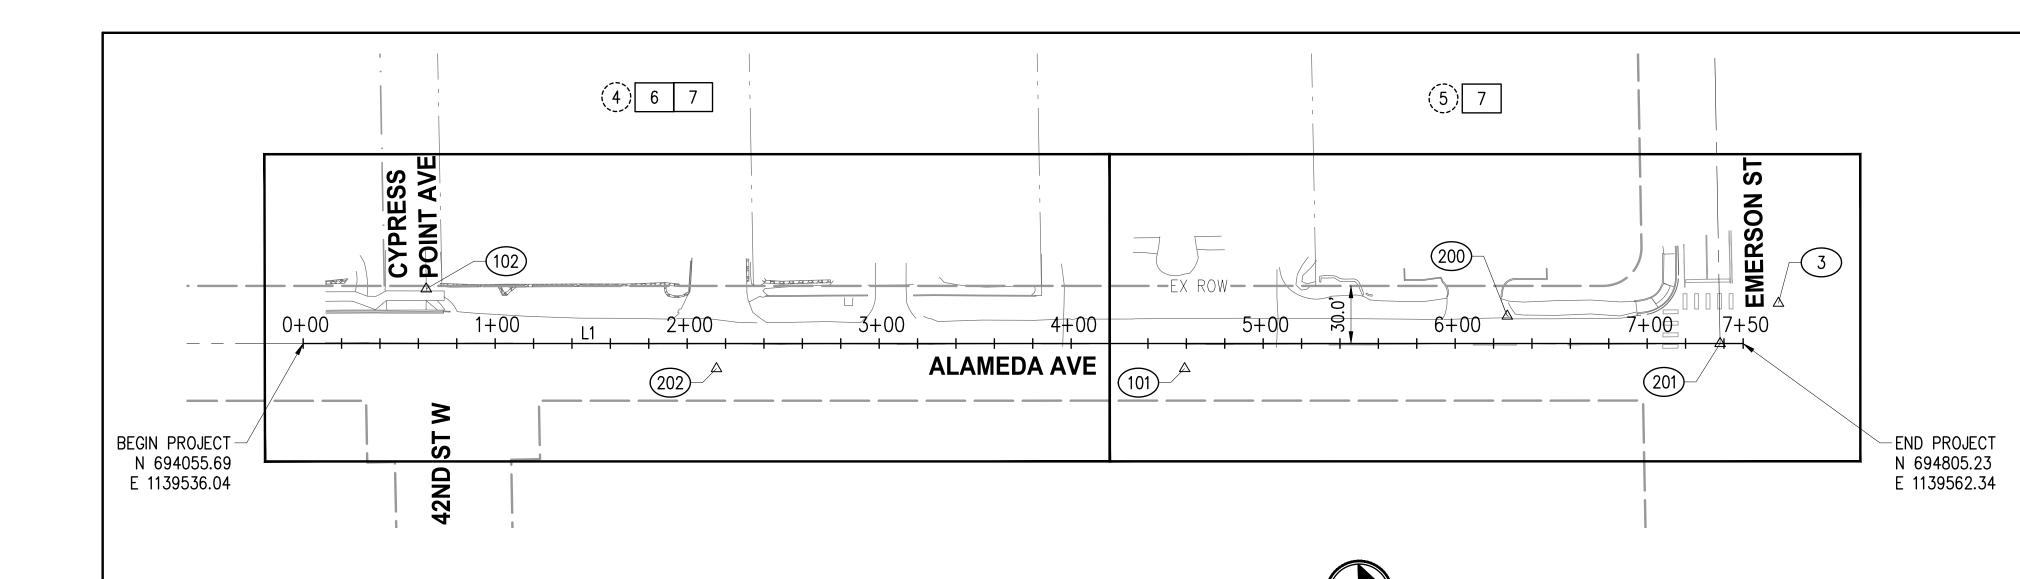

SCALE IN FEET

## SHEET INDEX

- SIDEWALK & STORMWATER PLANS
- # DRIVEWAY LAYOUTS

	CONTR	ROL POINT	LIST				
PT #)	DESCRIPTION	NORTHING	EASTING	ELEVATION			
3	SCRIBE	694824.34	1139542.01	307.10 <b>'</b>			
100 *	SPIKE	694772.60	1139126.67	325.85'			
101	SPIKE	694514.06	1139565.18	299.13'			
102	SPIKE	694120.75	1139509.86	289.64'			
104 *	SPIKE	693837.12	1139542.10	278.33'			
200	SPIKE	694682.97	1139543.74	304.13'			
201	MON / 2" BRASSIE W/PUNCH	694793.24	1139561.92	306.37'			
202	SPIKE	694270.37	1139556.66	293.57'			

\* NOT SHOWN ON PLANS

### NOTES

- 1. THE PURPOSE OF THIS TOPOGRAPHIC SURVEY IS FOR CIVIL ENGINEERING DESIGN. THIS IS NOT A BOUNDARY SURVEY. SOURCES OF BOUNDARY INFORMATION AS SHOWN INCLUDE FIELD—TIED MONUMENTATION, PLATS, COUNTY RECORDS OF SURVEY, AND AUDITOR INDEXING INFORMATION.
- 2. THE LOCATIONS OF EXISTING UNDERGROUND UTILITY SYSTEMS, AS SHOWN HEREON, ARE TAKEN FROM UTILITY LOCATE PAINT MARKS OR AS-BUILT PLANS AND ARE SHOWN IN AN APPROXIMATE WAY ONLY.

THE CONTRACTOR SHALL DETERMINE THE EXACT LOCATION OF ALL EXISTING UTILITIES BEFORE COMMENCING WORK, AND AGREES TO BE FULLY RESPONSIBLE FOR ANY AND ALL DAMAGES WHICH MIGHT BE OCCASIONED BY THE CONTRACTOR'S FAILURE TO EXACTLY LOCATE AND PRESERVE ANY AND ALL UNDERGROUND UTILITIES. ALL LOCATOR SERVICES SHOULD BE CONTACTED PRIOR TO ANY CONSTRUCTION OR SUBSURFACE EXPLORATION. CALL 1-800-424-5555.

- 3. FIELD SURVEY: KPG PSOMAS, APRIL, 2025. LICENSEE MICHAEL R. BOWEN, P.L.S. NO. 29294/BRYAN R. SHAW, P.L.S. NO. 49290.
- 4. CONTOUR INTERVAL = 1 FOOT,  $\pm 0.5$  FOOT PER NATIONAL MAPPING STANDARDS. CONTOURS DERIVED FROM DIRECT FIELD OBSERVATIONS.
- 5. STORM AND SEWER CONNECTIONS HAVE BEEN DRAWN FROM CENTER OF LID TO CENTER OF LID.
- 6. THE LOCATIONS AND DIMENSIONS OF UNDERGROUND VAULTS HAVE NOT BEEN VERIFIED AND ARE APPROXIMATE.
- 7. DUCTS ARE NOTED AS INDICATED IN THE FIELD BY UTILITY LOCATORS.
  MULTIPLE LINES AND/OR UTILITIES MAY SHARE DUCT RUNS; THIS MAY
  NOT BE SHOWN IN THE DRAWING.

#### HORIZONTAL AND VERTICAL DATUM

HORIZONTAL DATUM: NAD 83/11

VERTICAL DATUM NAVD 88

HORIZONTAL AND VERTICAL DATUMS ESTABLISHED BY RTK GPS
OBSERVATION UTILIZING WSRN (WASHINGTON STATE REFERENCE NETWORK)
WITH CHECKS TO WSDOT CONTROL POINTS "MAS".

# **EXISTING LEGEND**

 $\bigcirc$ 

LOT LIGHT

_/( •	10 2202115				
MIC	MONUMENT IN CASE	T	TELEPHONE RISER	SD	STORM
MON △	SURFACE MONUMENT	CO	UTILITY CLEAN-OUT (GENERIC/UNKNOWN)	S	SEWER
Δ	MAG NAIL/SPIKE		BOULDER	xxx	FENCE
RC O	REBAR & CAP	Т	SIGN		HEDGE (HEIGHT NOTED)
	CATCH BASIN	<b>⊠</b> 2	MAILBOX (# OF BOXES)		PAINTED STRIPE
	STORM DRAIN MANHOLE		SHRUB		PAINTED SKIP STRIPE
	CATCH BASIN (ROUND)	exx"	STUMP, DIAMETER		EDGE OF PAVEMENT
	SEWER MANHOLE	$\forall$	PLANTED AREA	_ · · _ · · _	FLOWLINE
-\$-	POWER POLE W/UNDERGROUND CONNECT	€XX"	DECIDUOUS TREE, DIAMETER (# OF TRUNKS)		CONTOUR
<b>—</b> ф	POWER POLE WITH LUMINAIRE AND UNDERGROUND CONNECT	XX XX	CONIFEROUS TREE, DIAMETER (# OF TRUNKS)		CONCRETE
Р	POWER RISER				GRAVEL
<b>─</b>	GUY ANCHOR			• •	GRASS
Š	PEDESTRIAN SIGNAL				ROCKERY
	JUNCTION BOX			AC	ASPHALT/CONCRETE
	UTILITY VAULT			CHLK	CHAINLINK

**BEARING** 

# PROPOSED LEGEND

CEMENT CONCRETE PAVEMENT

CRUSHED SURFACING CHOKER COURSE

2" GRIND AND OVERLAY

NEW HMA PAVEMENT

---- SAWCUT LINE

MODIFIED CATCH BASIN TYPE 2

MODULAR BLOCK WALL

— EXISTING ROW

## **ABBREVIATIONS**

AC		MAX	MAXIMUM
ADA	AMERICANS WITH DISABILITIES ACT		
APPROX	APPROXIMATE	MIC	
AVE	AVENUE	MIN	
BLVD	BOULEVARD	MUTCD	MANUAL ON UNIFORM TRAFFIC
BOW			CONTROL DEVICES
	CATCH BASIN	N	NORTHING/NORTH
	CONTROLLED DENSITY FILL	NO.	NUMBER
₢/CL	CENTERLINE	NTS	
CL	CLASS	PC	
CO	CLEANOUT	PT	
CONC		PVI	
C.O.F./COF	CITY OF FIRCREST	PG	PERFORMANCE GRADE
	CRUSHED SURFACING CHOKER COURSE		
CSTC	CRUSHED SURFACING TOP COURSE		
DI	DUCTILE IRON	•	RIGHT OF WAY
DIA	DIAMETER	S	SLOPE/SOUTH
DWY		SD	STORM DRAIN
E	•	SHT	SHEET
EG	EXISTING GRADE	SS	SANITARY SEWER
EL/ELEV	ELEVATION	SSMH	SANITARY SEWER MANHOLE
EX/EXST	EXISTING	ST	STREET
FG	FINISHED GRADE	STA	STATION
FL	FLOW LINE	STD	STANDARD
FOC	FACE OF CURB	T	TANGENT LENGTH
HP	HIGH POINT	TOC	TOP OF CURB
HMA	HOT MIX ASPHALT	TOW	TOP OF WALL
IE	INVERT ELEVATION	TYP	TYPICAL
INCL	INCLUDING	UG	UNDERGROUND
LENGTH	LENGTH	VERT	VERTICAL
LT	LEFT	W	WATER/WEST
LF	LINEAR FEET	W/	WITH
LP	LOW POINT	WSDOT	WASHINGTON STATE DEPARTMENT
LS	LANDSCAPE		OF TRANSPORTATION


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							HH	09/2025
					PROJECT MANAGER	DATE	DRAWN BY	DATE
							DPY	09/2025
					PROJECT ENGINEER	DATE	CHECKED BY	DATE

ALAMEDA AVE CONSTRUCTION CENTERLINE

694055.69 | 1139536.04 | 750.00' | N 2°00'34" E

NUMBER | START STA | NORTHING | EASTING | LENGTH

0+00.0

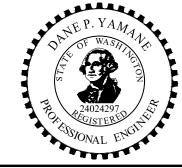



DWY

DRIVEWAY


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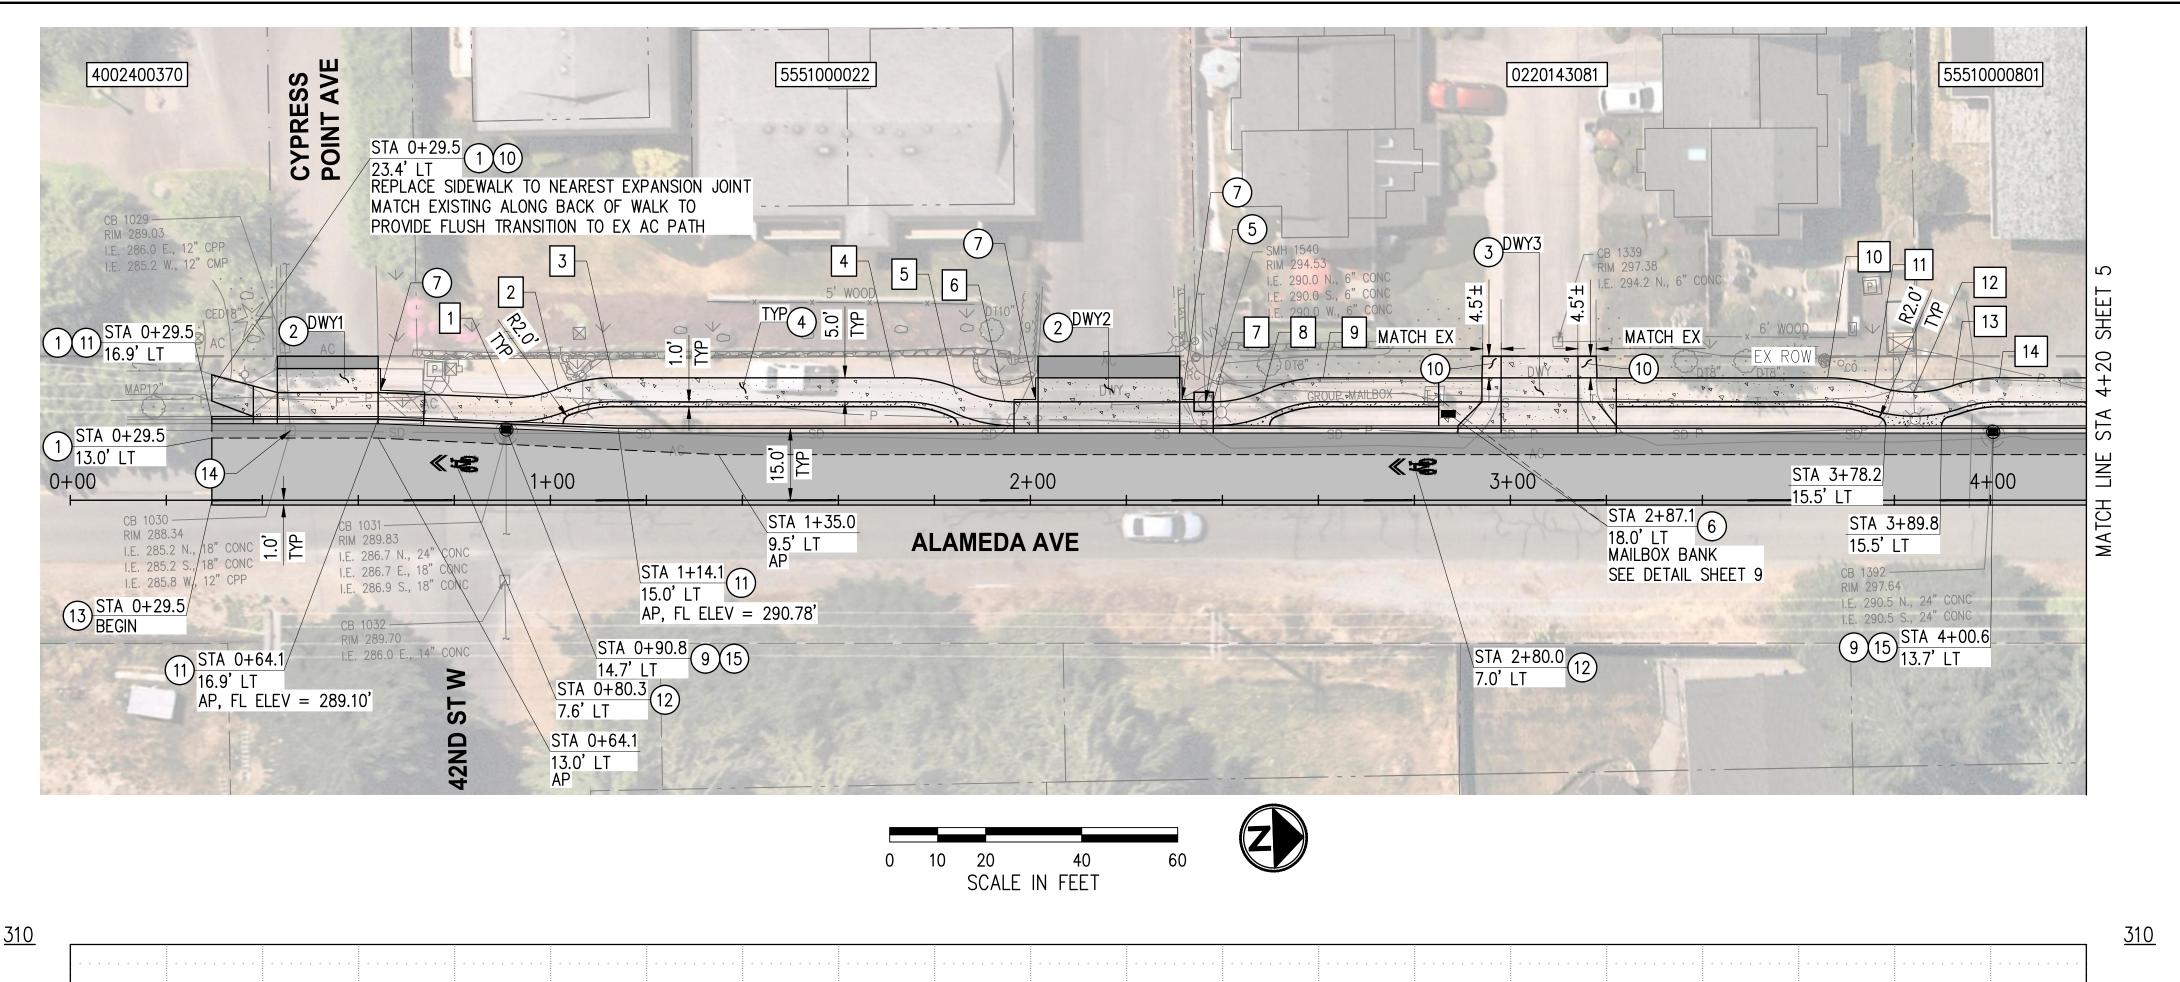



CITY OF FIRCREST
ALAMEDA AVENUE SIDEWALKS EXTENSION
CYPRESS POINT AVE TO EMERSON STREET

LEGEND, ABBREVIATIONS,
ALIGNMENT & SURVEY CONTROL

PROJ. No. 9FIR010400 SHT 2 OF 9



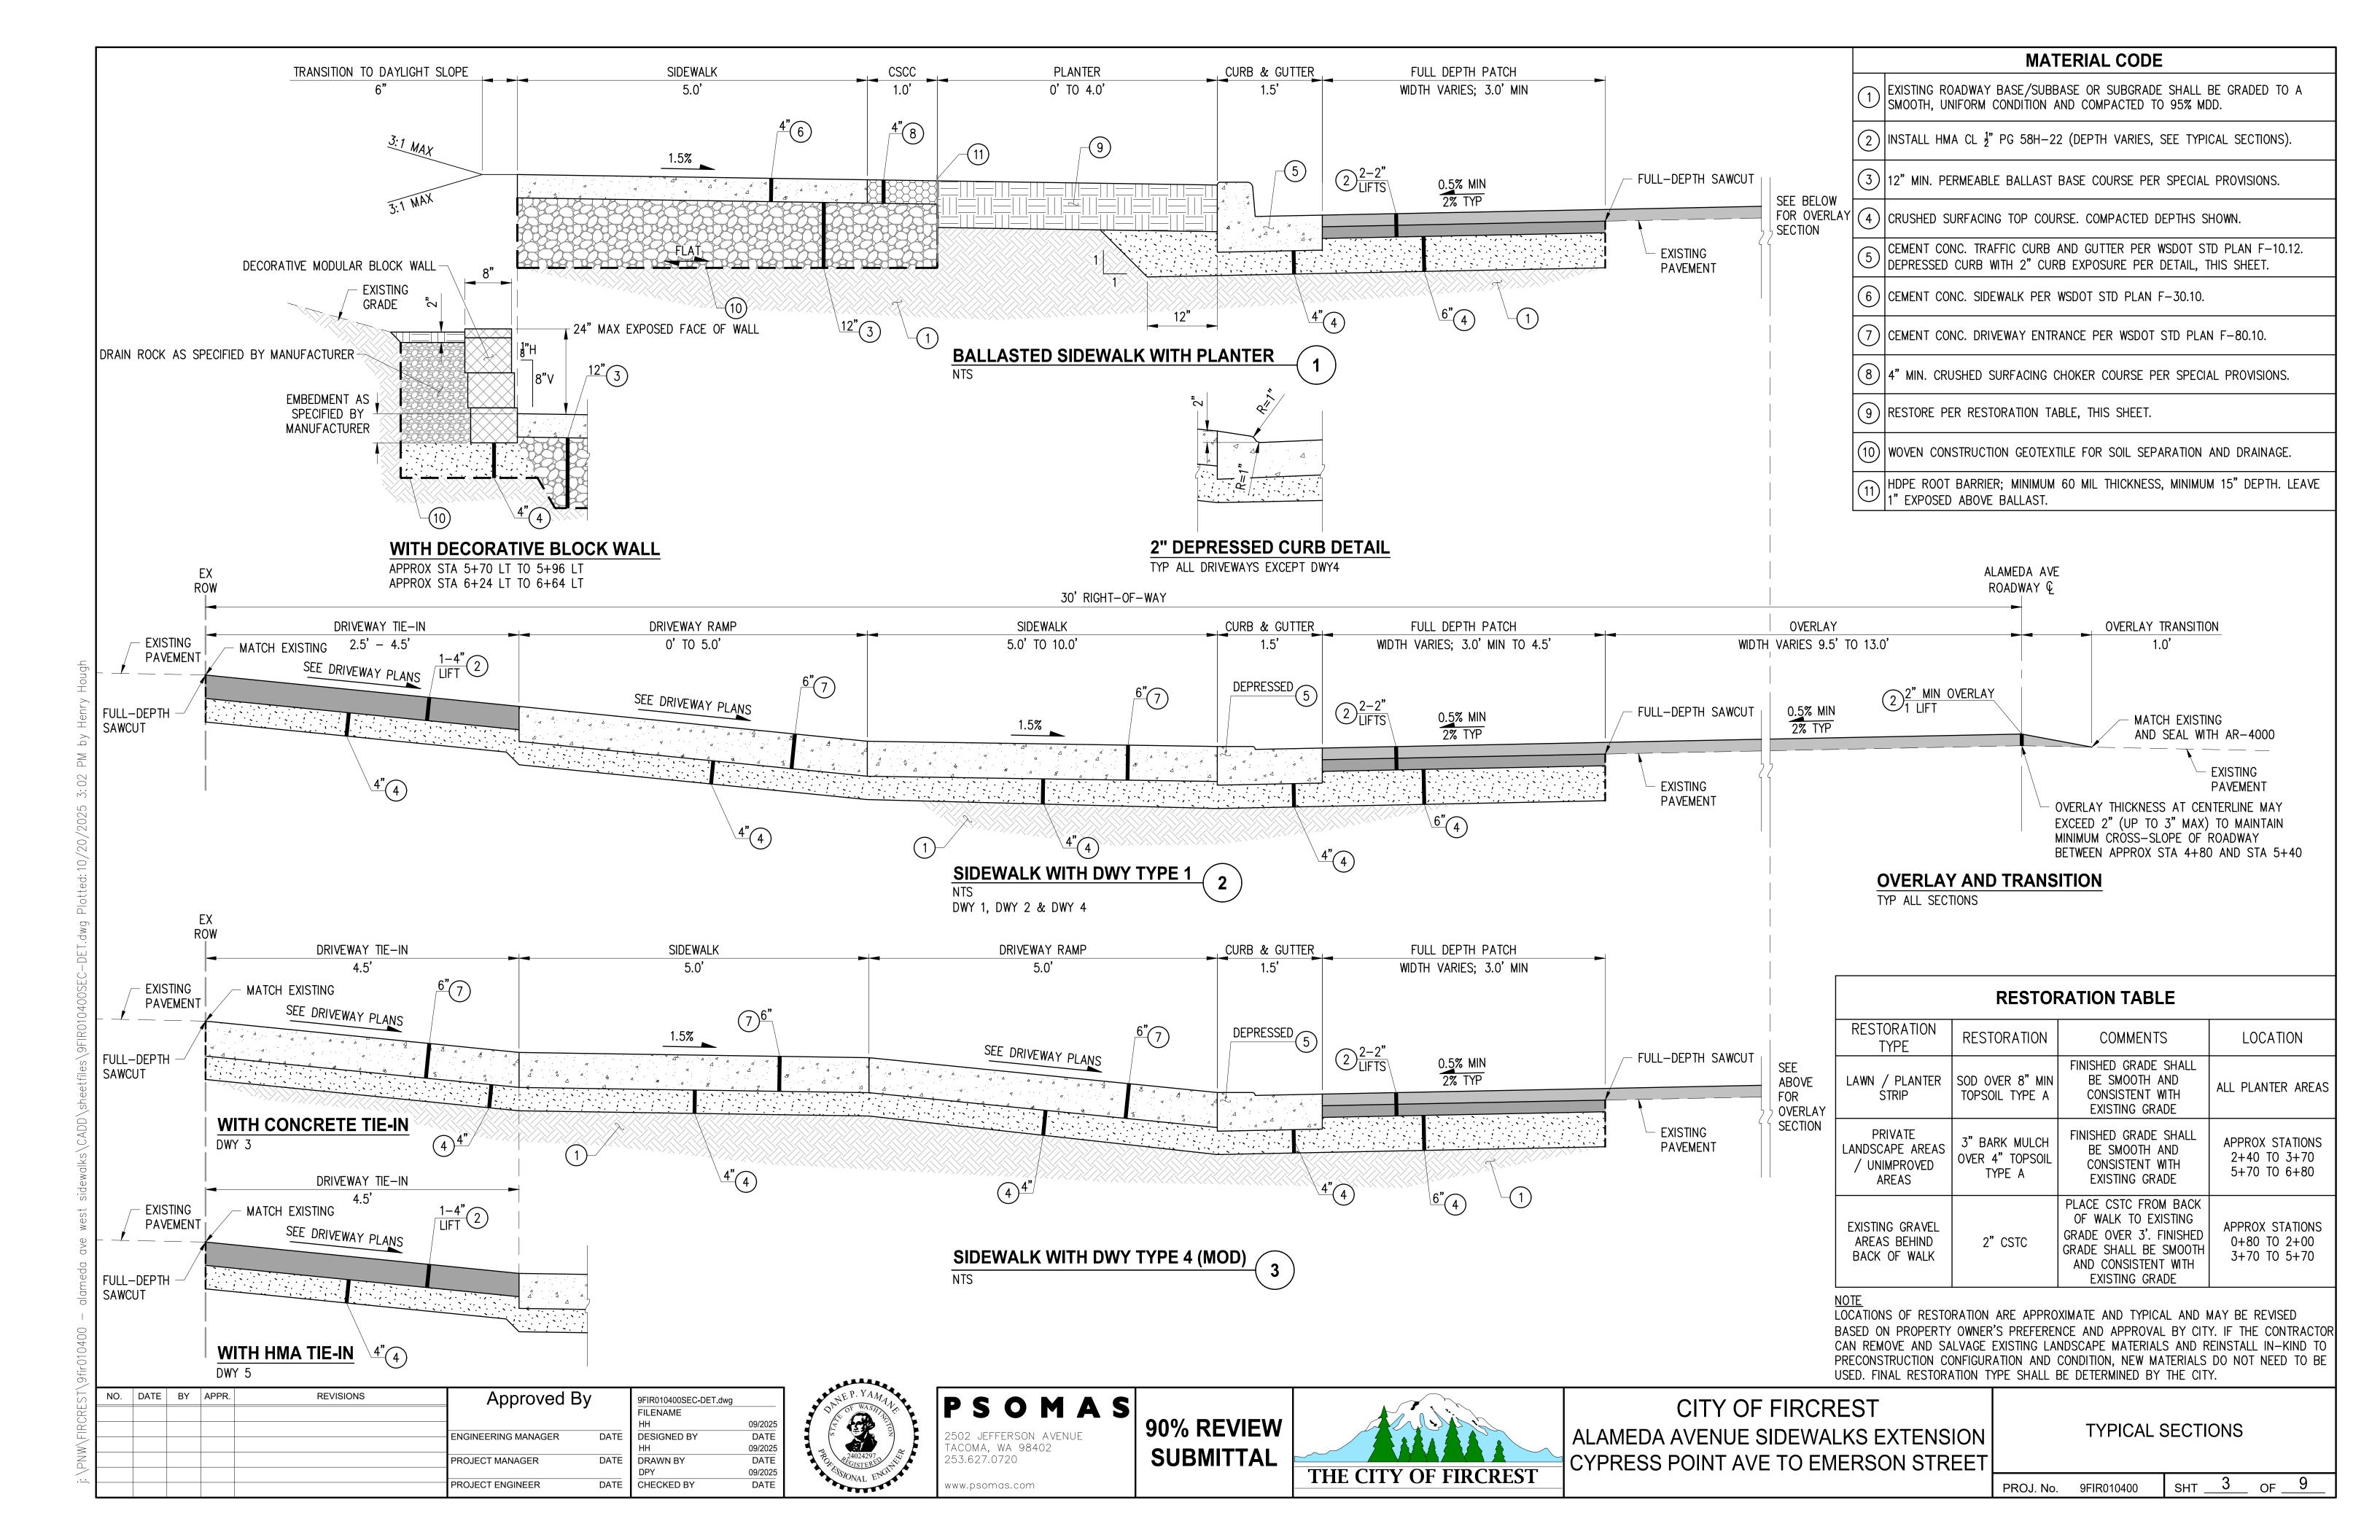

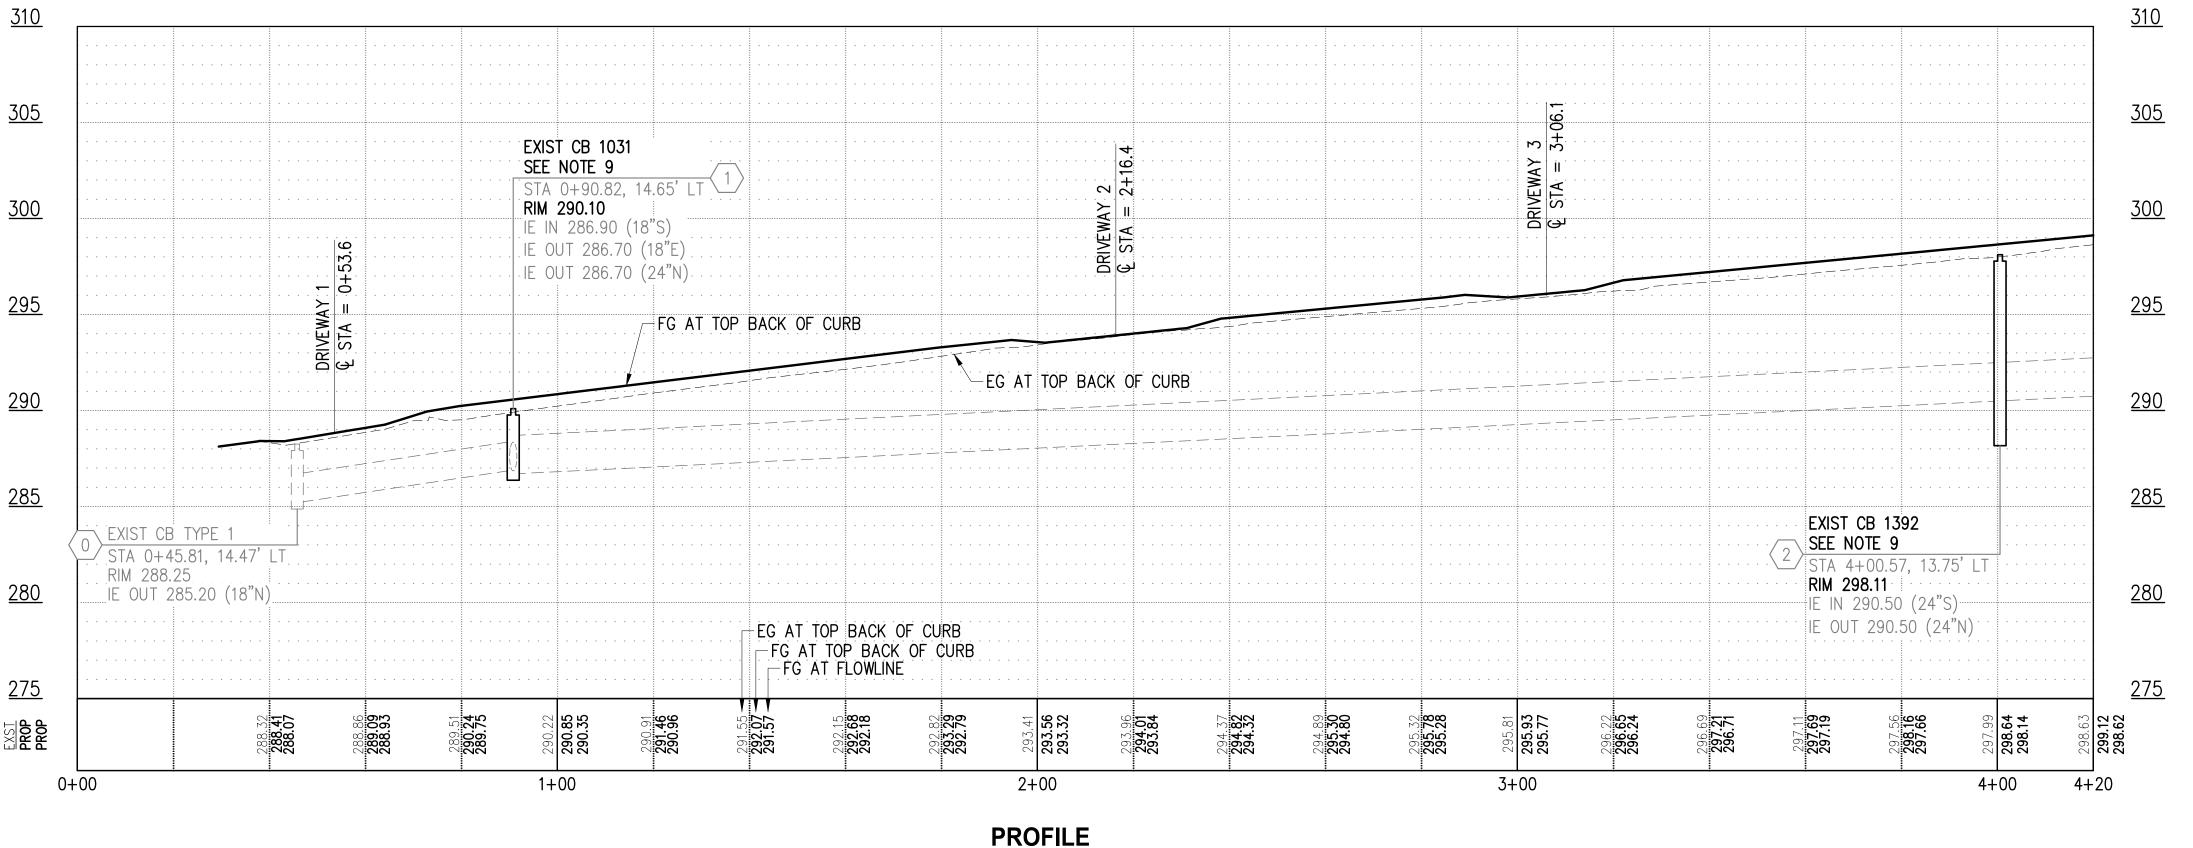

#### **GENERAL NOTES**


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- 2. PROPOSED CURB & GUTTER, SIDEWALK, AND DRIVEWAYS SHALL BE INSTALLED PER THEIR RESPECTIVE WSDOT STD PLANS AND TYPICAL SECTIONS, SHEET 3.
- 3. ALL AREAS DISTURBED BUT NOT SPECIFICALLY SHOWN FOR RESTORATION IN THE PLANS SHALL BE RESTORED PER THE RESTORATION TABLE, SHEET 3.
- 4. PRESERVE AND PROTECT ALL IMPROVEMENTS AND STRUCTURES NOT SPECIFICALLY MARKED FOR REMOVAL.
- 5. CONSTRUCTION ACTIVITIES SHALL BE PHASED AS NECESSARY TO MAINTAIN ACCESS FOR RESIDENTS. DRIVEWAY CLOSURES SHALL BE COORDINATED WITH THE ENGINEER AND PROPERTY OWNER A MINIMUM OF 2 WORKING DAYS IN ADVANCE.
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- 7. CONTRACTOR SHALL FURNISH, INSTALL, AND MAINTAIN INLET PROTECTION, SILT FENCE, WATTLES, AND OTHER EROSION CONTROL MEASURES TO MINIMIZE SEDIMENT MIGRATION INTO STORM DRAINAGE SYSTEMS WITHIN THE PROJECT LIMITS AND 100' DOWNSTREAM OF THE PROJECT LIMITS.

## **CONSTRUCTION NOTES**

- 1) MATCH EXISTING.
- 2 INSTALL CEMENT CONC DRIVEWAY ENTRANCE TYPE 1 PER WSDOT STD PLAN F-80.10. SEE DRIVEWAY PLAN & PROFILE, SHEET 6.
- INSTALL CEMENT CONC DRIVEWAY ENTRANCE TYPE 4 (MODIFIED) PER WSDOT STD PLAN F-80.10. SEE DRIVEWAY PLAN & PROFILE, SHEET 7.
- (4) INSTALL BALLASTED CEMENT CONC SIDEWALK PER SECTION 1, SHEET 3.
- 5 ADJUST MANHOLE RING AND COVER TO GRADE AND INSTALL 3" CONCRETE COLLAR AND NON-SKID LID.
- (6) REMOVE, SALVAGE AND RELOCATE TO CENTER OF PLANTER STRIP.
- (7) INSTALL CEMENT CONC PEDESTRIAN CURB PER WSDOT STD PLAN F-10.12.
- 9 REMOVE EXISTING RING FRAME, COVER AND GRADE RINGS. INSTALL NEW CURB INLET FRAME ADAPTER, GRADE RINGS, VANED GRATE, AND ADJUST TO FINISHED GRADE. ROTATE CB TOP BARREL SECTION AS NECESSARY TO ALIGN EDGE OF VANED GRATE WITH FLOWLINE. SEE CURB INLET FRAME ADAPTER, SHEET 9 AND SPECIAL PROVISIONS.
- (10) INSTALL CEMENT CONC SIDEWALK PER WSDOT STD PLAN F-30.10.
- INSTALL CEMENT CONC TRAFFIC CURB AND GUTTER PER WSDOT STD PLAN F-10.12 AND DEPRESSED CURB DETAIL, SHEET 3.
- (12) WHITE MMA SHARED LANE MARKING PER MUTCD FIGURE 9C-9.
- (13) YELLOW CENTERLINE MARKING PER MUTCD FIGURE 3B-1(A).
- (14) ADJUST EXISTING UTILITY TO FINISHED GRADE.
- REMOVE ADJUSTMENT BRICKS AS REQUIRED TO ALLOW DRAINAGE UNTIL FINAL LIFT OF HMA IS INSTALLED THEN FINISH FINAL ADJUSTMENT OF FRAME AND GRATE.

	BOW	/ LAYO	JT PO	INTS	BOW LAYOUT POINTS				
#	STATION	OFFSET	ELEV	DESCRIPTION	#	STATION	OFFSET	ELEV	DESCRIPTION
1	0+91.1	21.4' LT	290.7	PC, R=25'	12	3+84.0	22.5' LT	298.4	MIDPOINT
2	1+01.6	23.2' LT	291.0	PRC, R=30'	13	3+92.1	23.9' LT	298.6	PRC, R=30'
3	1+13.0	25.5' LT	291.4	PT	14	4+01.9	25.5' LT	298.8	PT
4	1+71.7	25.5' LT	293.2	PC, R=30'	<u>LE</u>	GEND			
5	1+84.2	22.8' LT	293.5	PRC, R=25'	4.	CE	MENT CONC	RETE PA	VEMENT
6	1+94.7	20.5' LT	293.7	PT		CR	USHED SUR	FACING	CHOKER COURSE
7	2+38.1	20.5' LT	294.8	PC, R=25'		NE	W HMA PAV	/EMENT	
8	2+48.5	22.8' LT	295.1	PRC, R=30'		2"	GRIND AND	OVERLA	ΛΥ
9	2+61.0	25.5' LT	295.5	PT		——— ——— SA	WCUT LINE		
10	3+66.1	25.5' LT	298.0	PC, R=30'		● MC	DIFIED CAT	CH BASII	N TYPE 2
11	3+75.9	23.9' LT	298.2	PRC, R=25'		— EX	ISTING ROW		

Approved By NO. DATE BY APPR. **REVISIONS** 9FIR010400STRM01.dwa **FILENAME** 09/2025 DATE ENGINEERING MANAGER DESIGNED BY 09/2025 DATE ROJECT MANAGER DRAWN BY 09/2025 DATE DATE CHECKED BY ROJECT ENGINEER

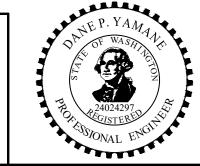

PSOMAS

2502 JEFFERSON AVENUE
TACOMA, WA 98402
253.627.0720

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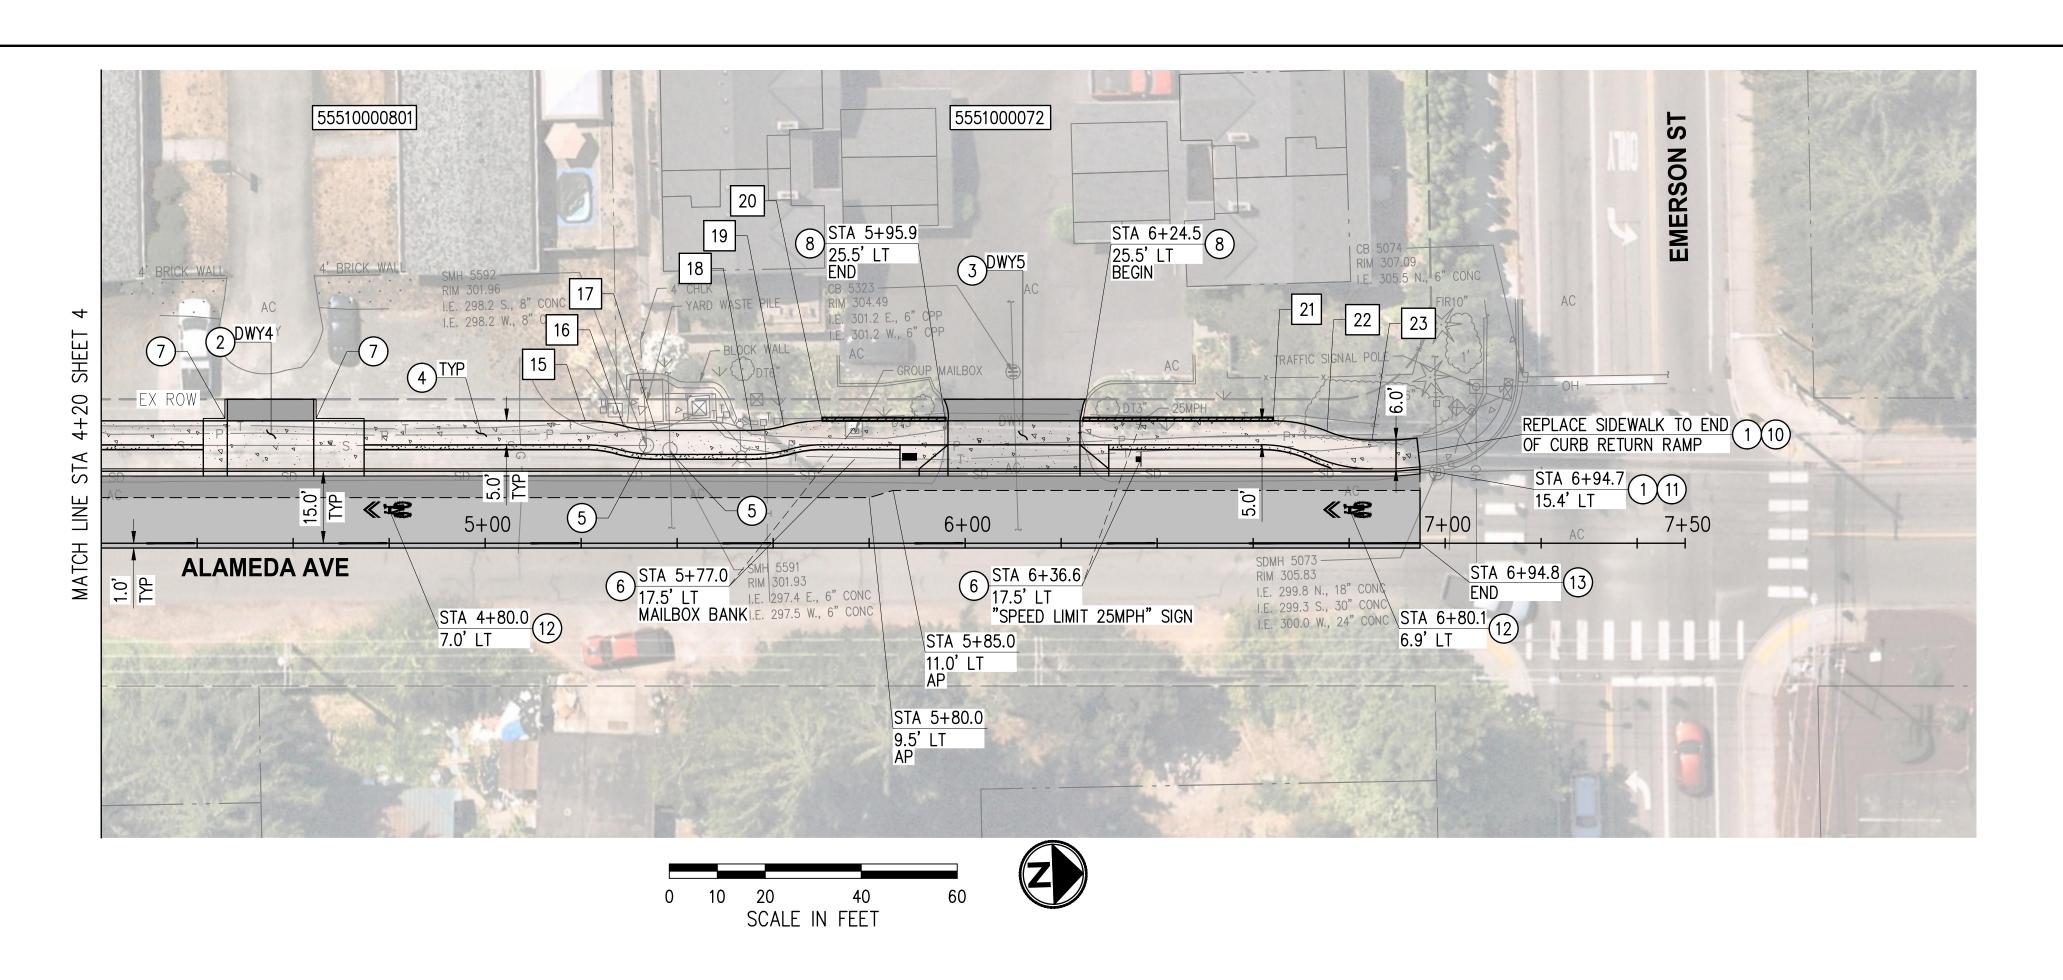
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ALAMEDA AVENUE SIDEWALKS EXTENSION
CYPRESS POINT AVE TO EMERSON STREET


SIDEWALK & STORMWATER PLAN & PROFILE

ALAMEDA AVE

STA 0+00 TO STA 4+20

PROJ. No. 9FIR010400 SHT 4 OF 9



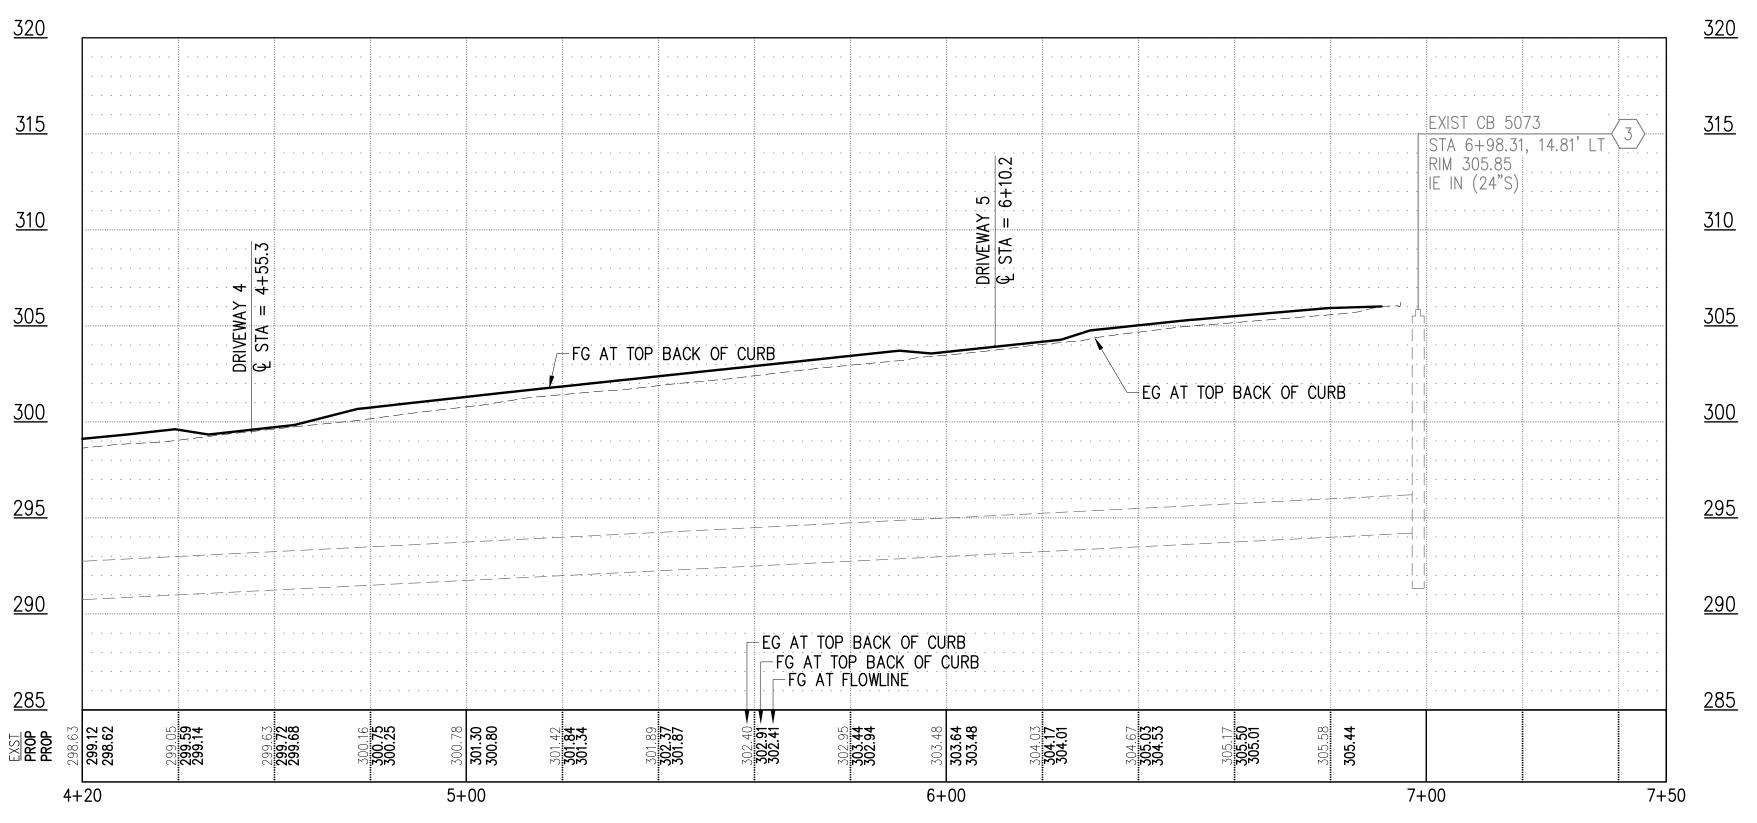

**PROFILE** 

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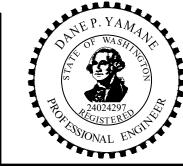
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- (6) REMOVE, SALVAGE AND RELOCATE TO CENTER OF PLANTER STRIP.
- (7) INSTALL CEMENT CONC PEDESTRIAN CURB PER WSDOT STD PLAN F-10.12.
- 8 INSTALL DECORATIVE MODULAR BLOCK WALL PER SECTIONS AND DETAILS, SHEET 3, AND SPECIAL PROVISIONS.
- (10) INSTALL CEMENT CONC SIDEWALK PER WSDOT STD PLAN F-30.10.
- INSTALL CEMENT CONC TRAFFIC CURB AND GUTTER PER WSDOT STD PLAN F-10.12 AND DEPRESSED CURB DETAIL, SHEET 3.
- 12) WHITE MMA SHARED LANE MARKING PER MUTCD FIGURE 9C-9.
- (13) YELLOW CENTERLINE MARKING PER MUTCD FIGURE 3B-1(A).

	BOW	/ LAYOU	JT PO	INTS		
#	STATION	OFFSET	ELEV	DESCRIPTION		
15	5+20.9	25.5' LT	302.0	PC, R=30'		
16	5+28.9	24.4' LT	302.2	PRC, R=25'		
17	5+35.6	23.5' LT	302.4	PT		
18	5+55.6	23.5' LT	302.9	PC, R=25'	<b>LEGEND</b>	
19	5+62.2	24.4' LT	303.1	PRC, R=30'	4 <u>4</u> .	CEMENT CONCRETE PAVEMENT
20	5+70.2	25.5' LT	303.3	PT BEGIN WALL		CRUSHED SURFACING CHOKER COURSE
						NEW HMA PAVEMENT
21	6+64.2	25.5' LT	305.7	END WALL PC, R=30'		2" GRIND AND OVERLAY
22	6+75.4	23.3' LT	306.0	PRC, R=25'		SAWCUT LINE
23	6+84.8	21.5' LT	306.1	PT		MODULAR BLOCK WALL
						EVICTING DOW

— — EXISTING ROW

-									
	NO.	DATE	BY	APPR.	REVISIONS	Approved By		9FIR010400STRM01.dwg	
						] ''		FILENAME	
								НН	09/2025
_						ENGINEERING MANAGER	DATE	DESIGNED BY	DATE
								НН	09/2025
						PROJECT MANAGER	DATE	DRAWN BY	DATE
-								DPY	09/2025
`						PROJECT ENGINEER	DATE	CHECKED BY	DATE





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CITY OF FIRCREST


ALAMEDA AVENUE SIDEWALKS EXTENSION


CYPRESS POINT AVE TO EMERSON STREET

SIDEWALK & STORMWATER PLAN & PROFILE
ALAMEDA AVE

STA 4+20 TO STA 7+50

PROJ. No. 9FIR010400 SHT \_\_5 OF \_\_9

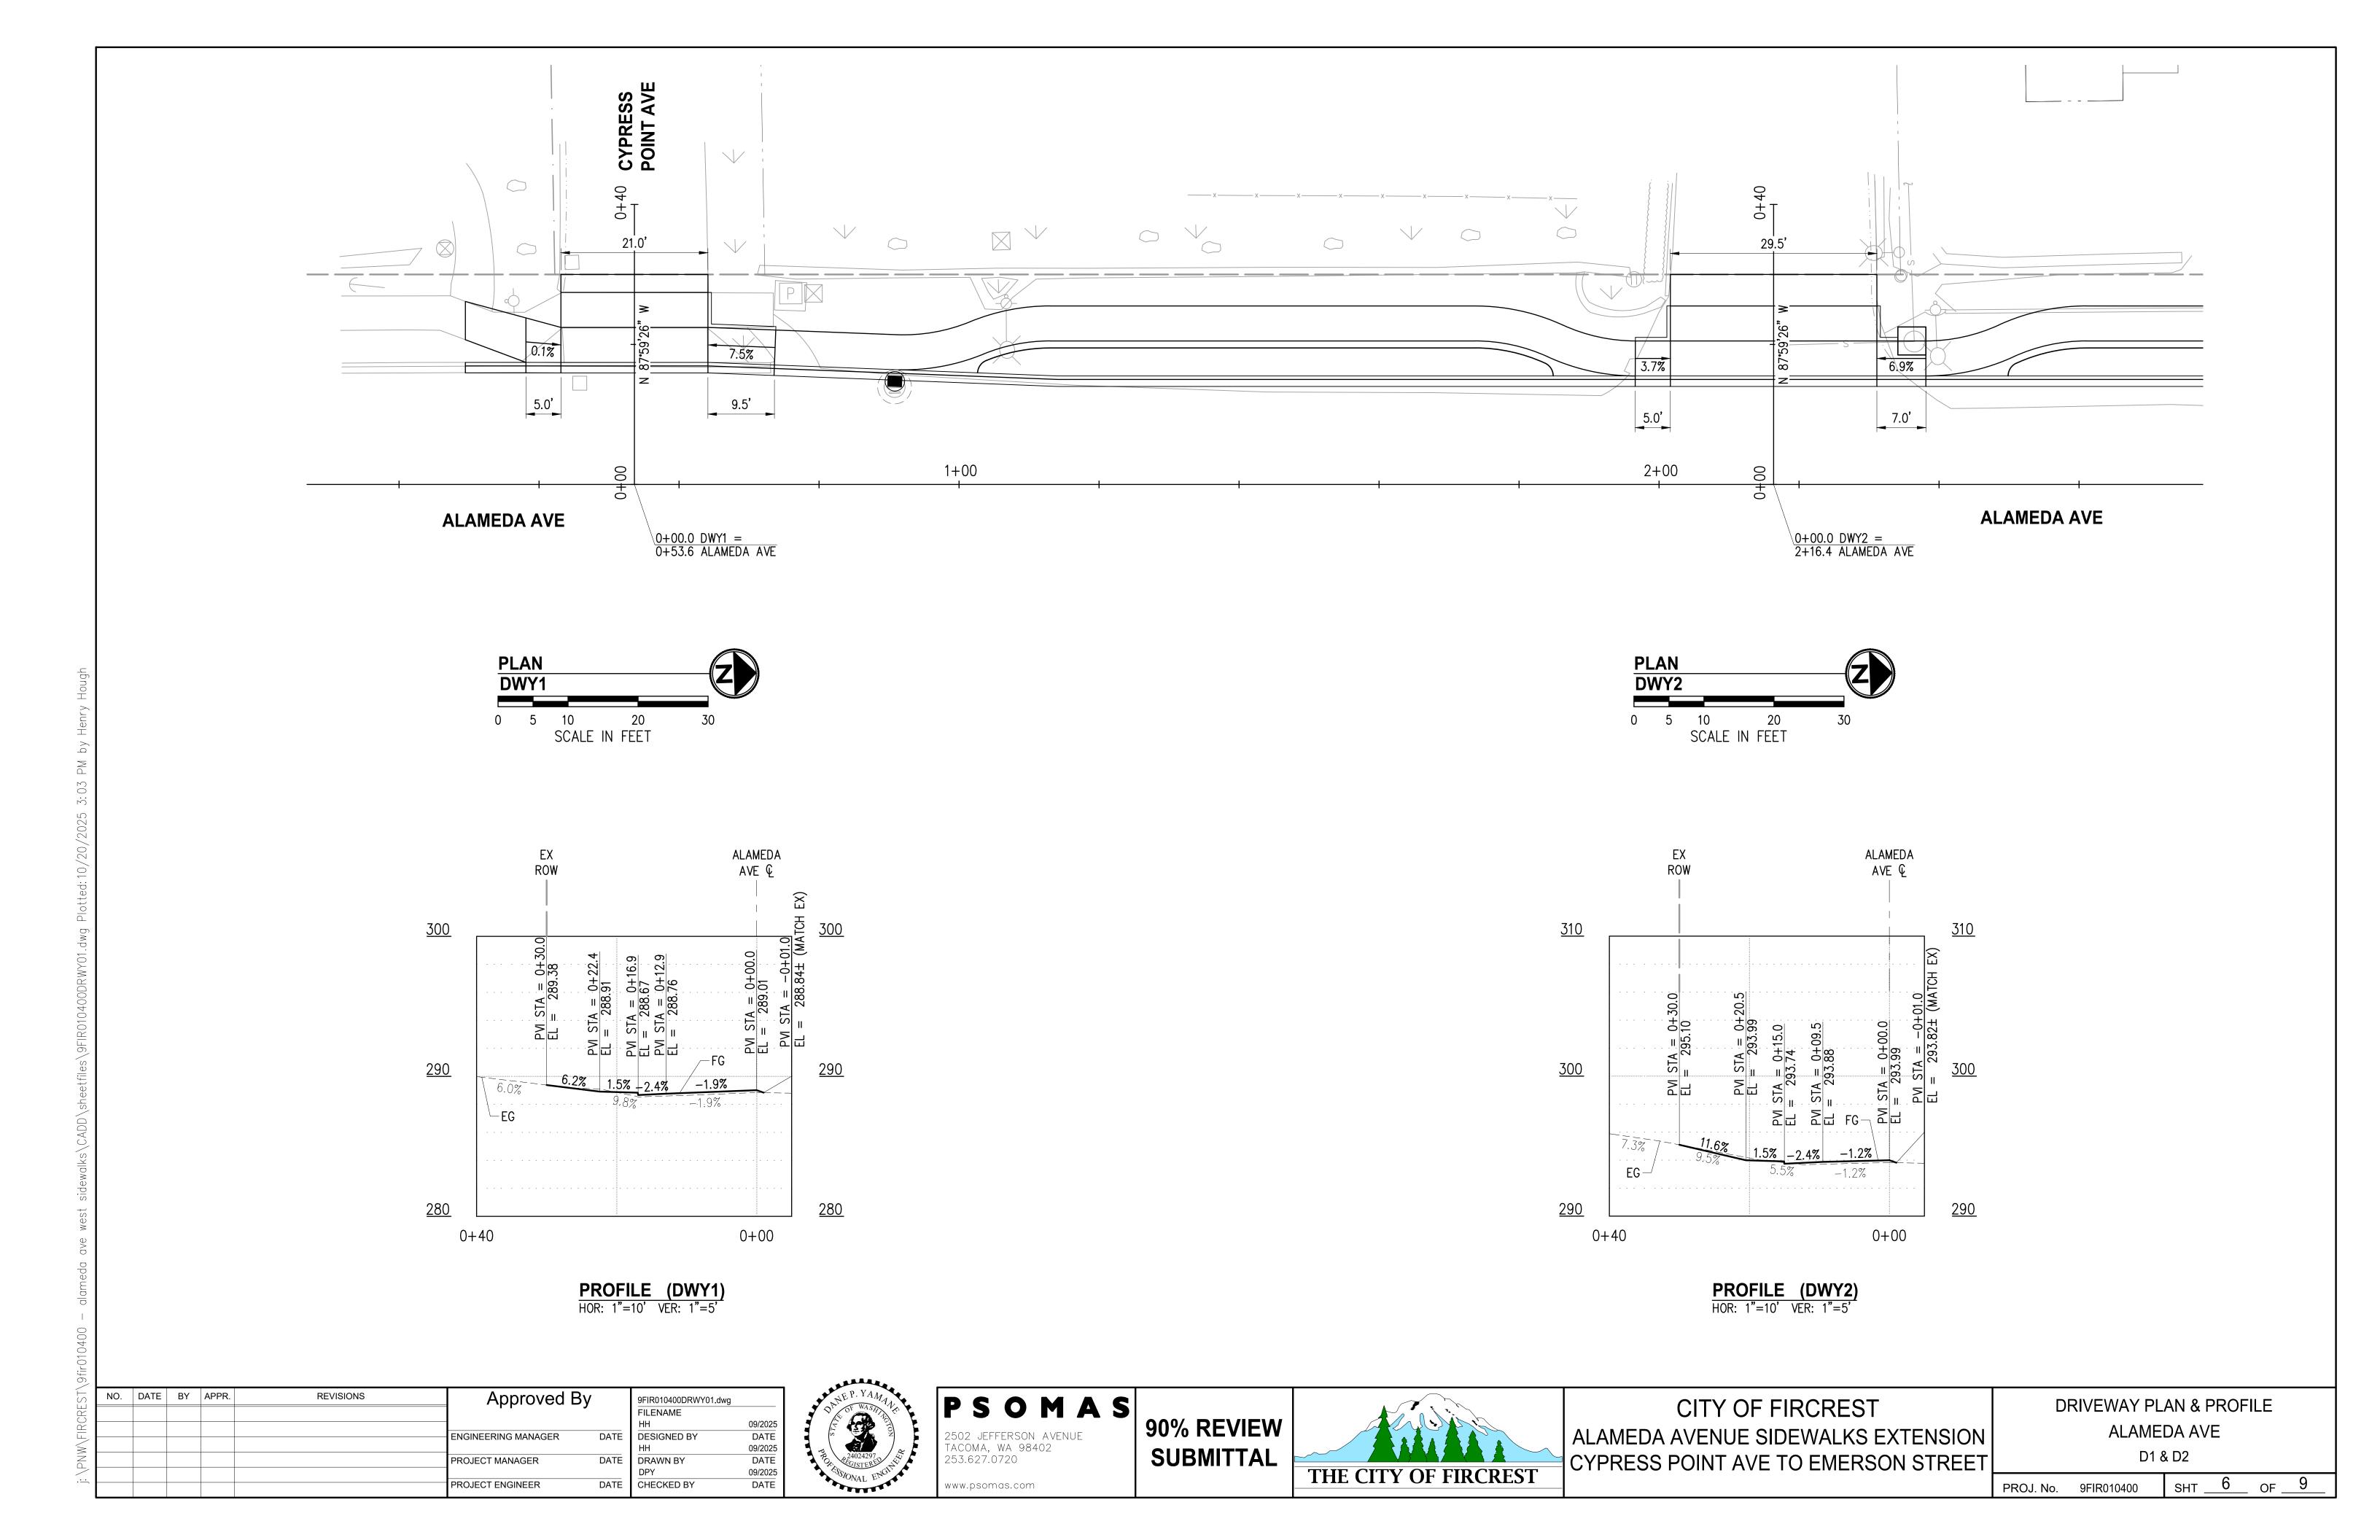

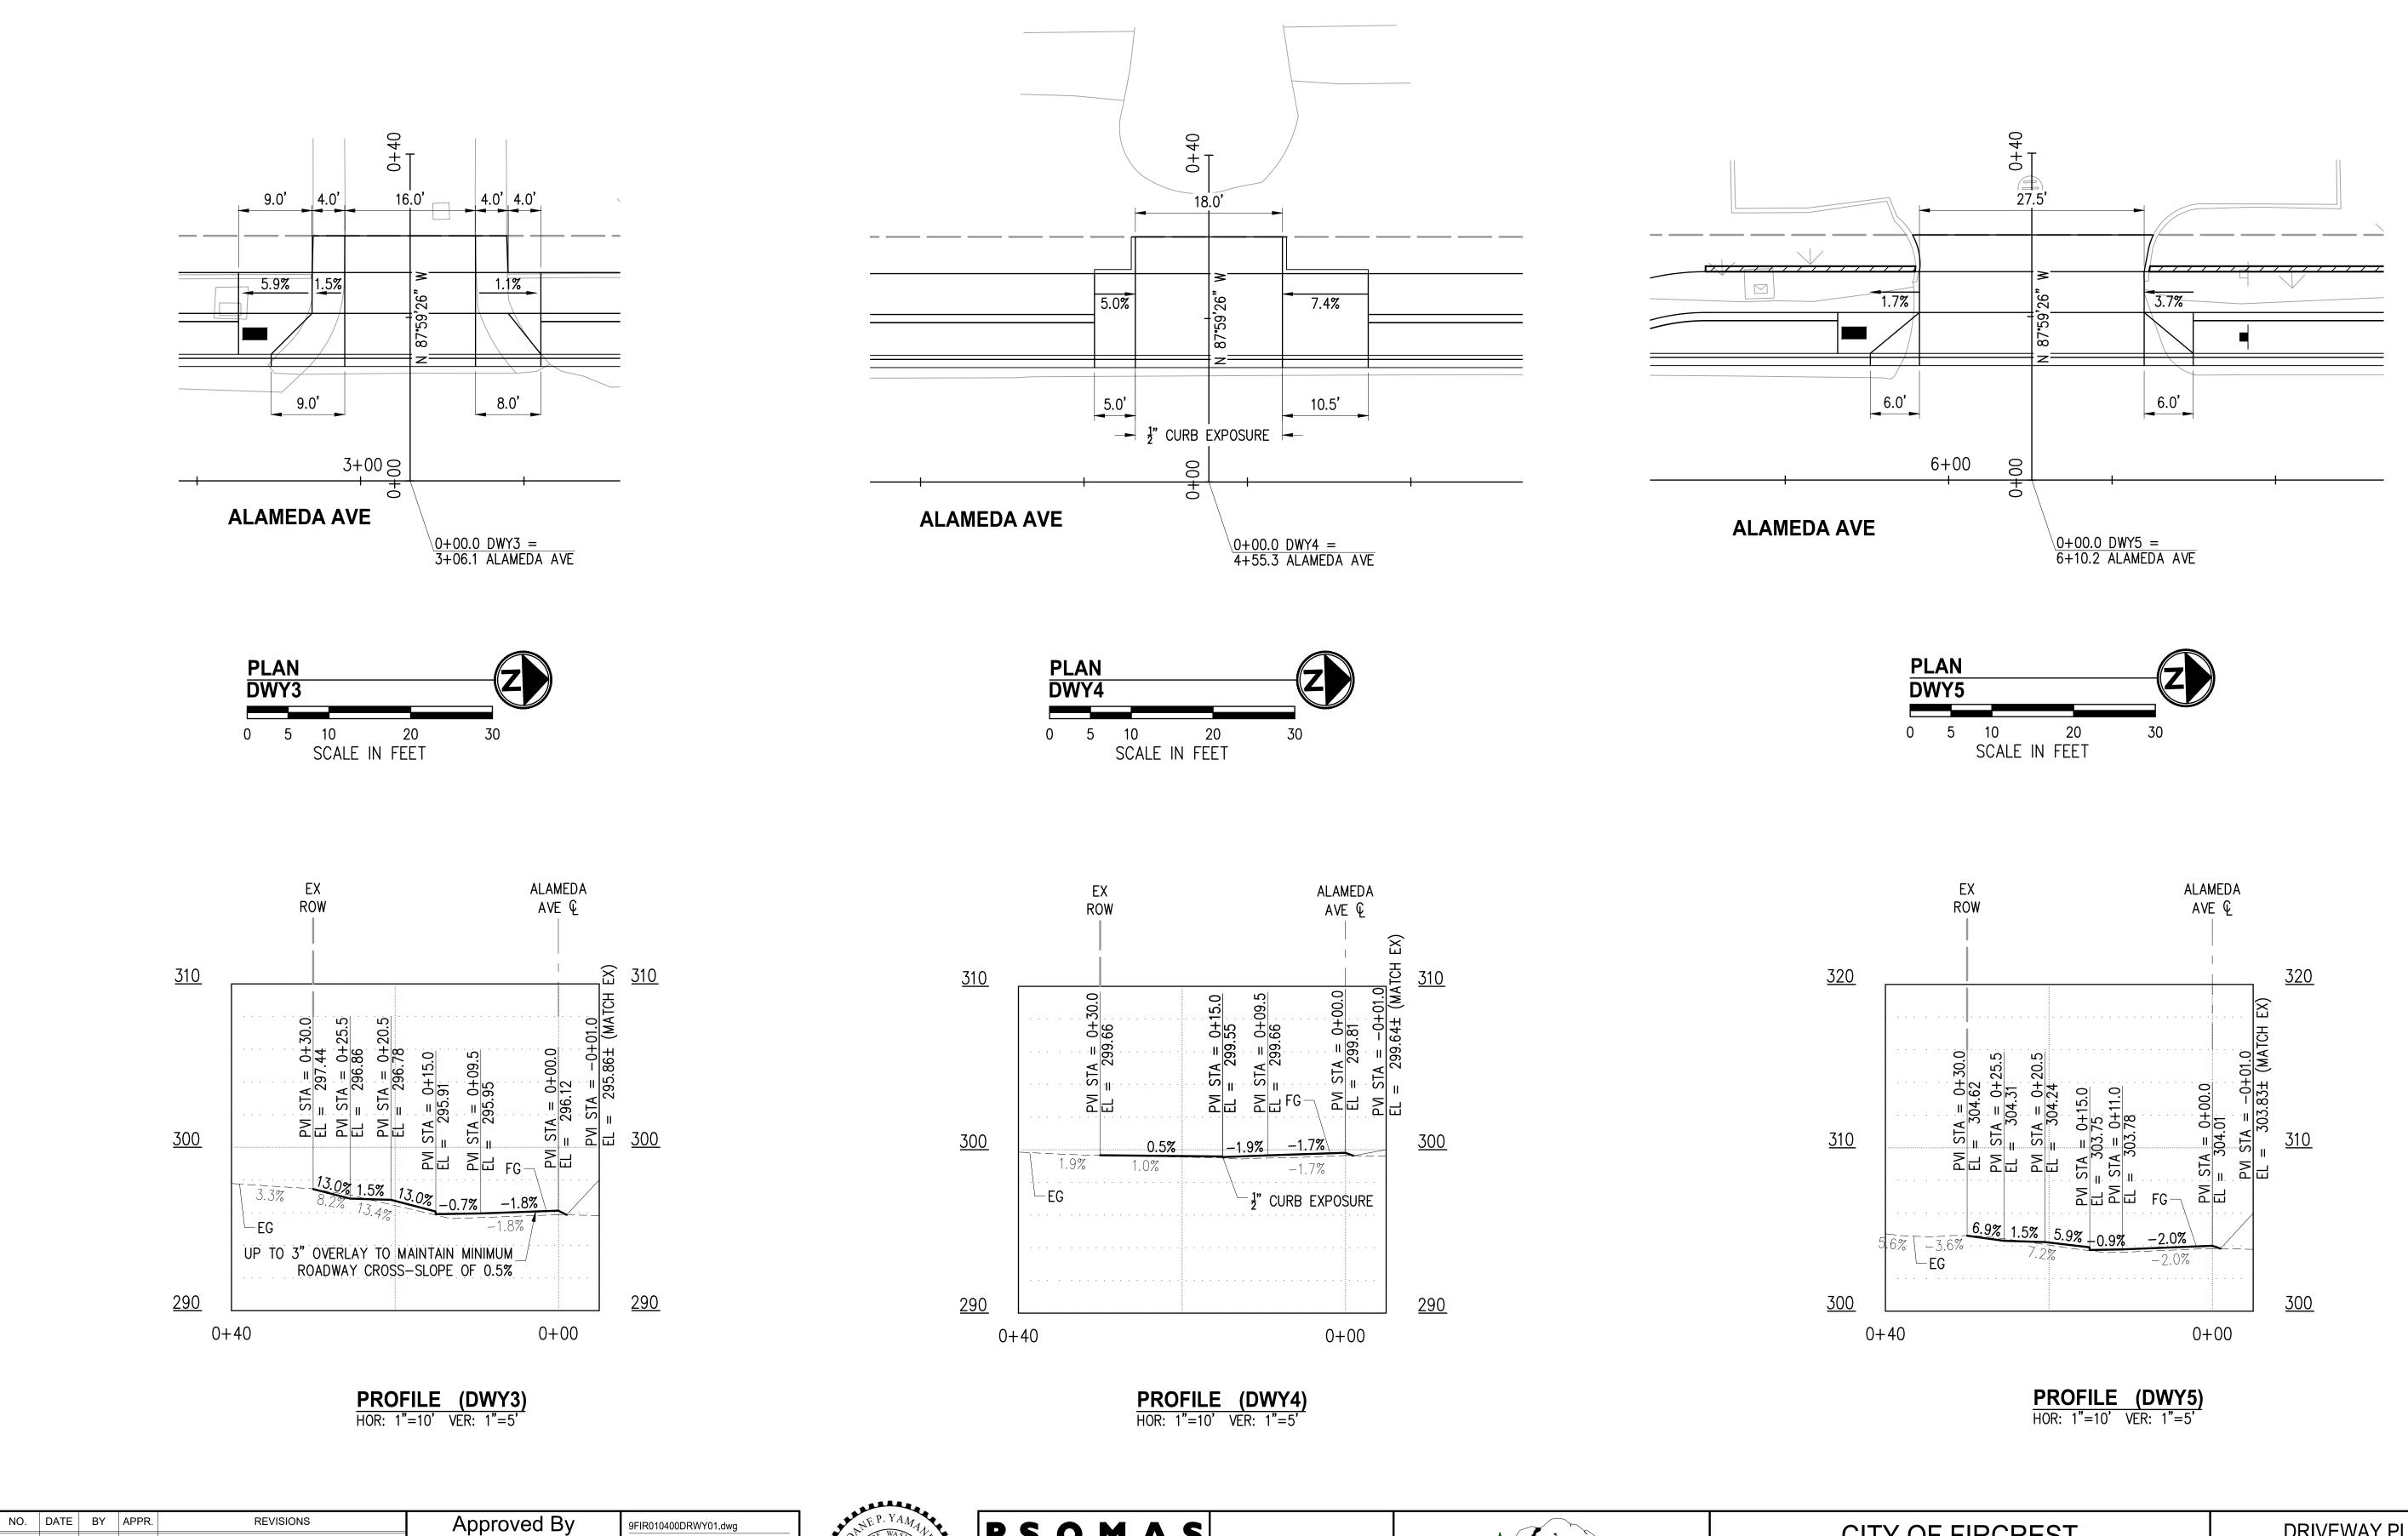

9FIR010400DRWY01.dwg 09/2025 DATE 09/2025 DATE 09/2025 DATE

FILENAME

DESIGNED BY


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DATE CHECKED BY

ROJECT MANAGER

PROJECT ENGINEER






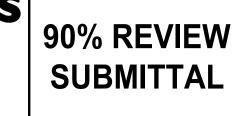

CITY OF FIRCREST ALAMEDA AVENUE SIDEWALKS EXTENSION CYPRESS POINT AVE TO EMERSON STREET

DRIVEWAY PLAN & PROFILE ALAMEDA AVE D3, D4 & D5

SHT \_\_\_7 OF \_\_9 PROJ. No. 9FIR010400

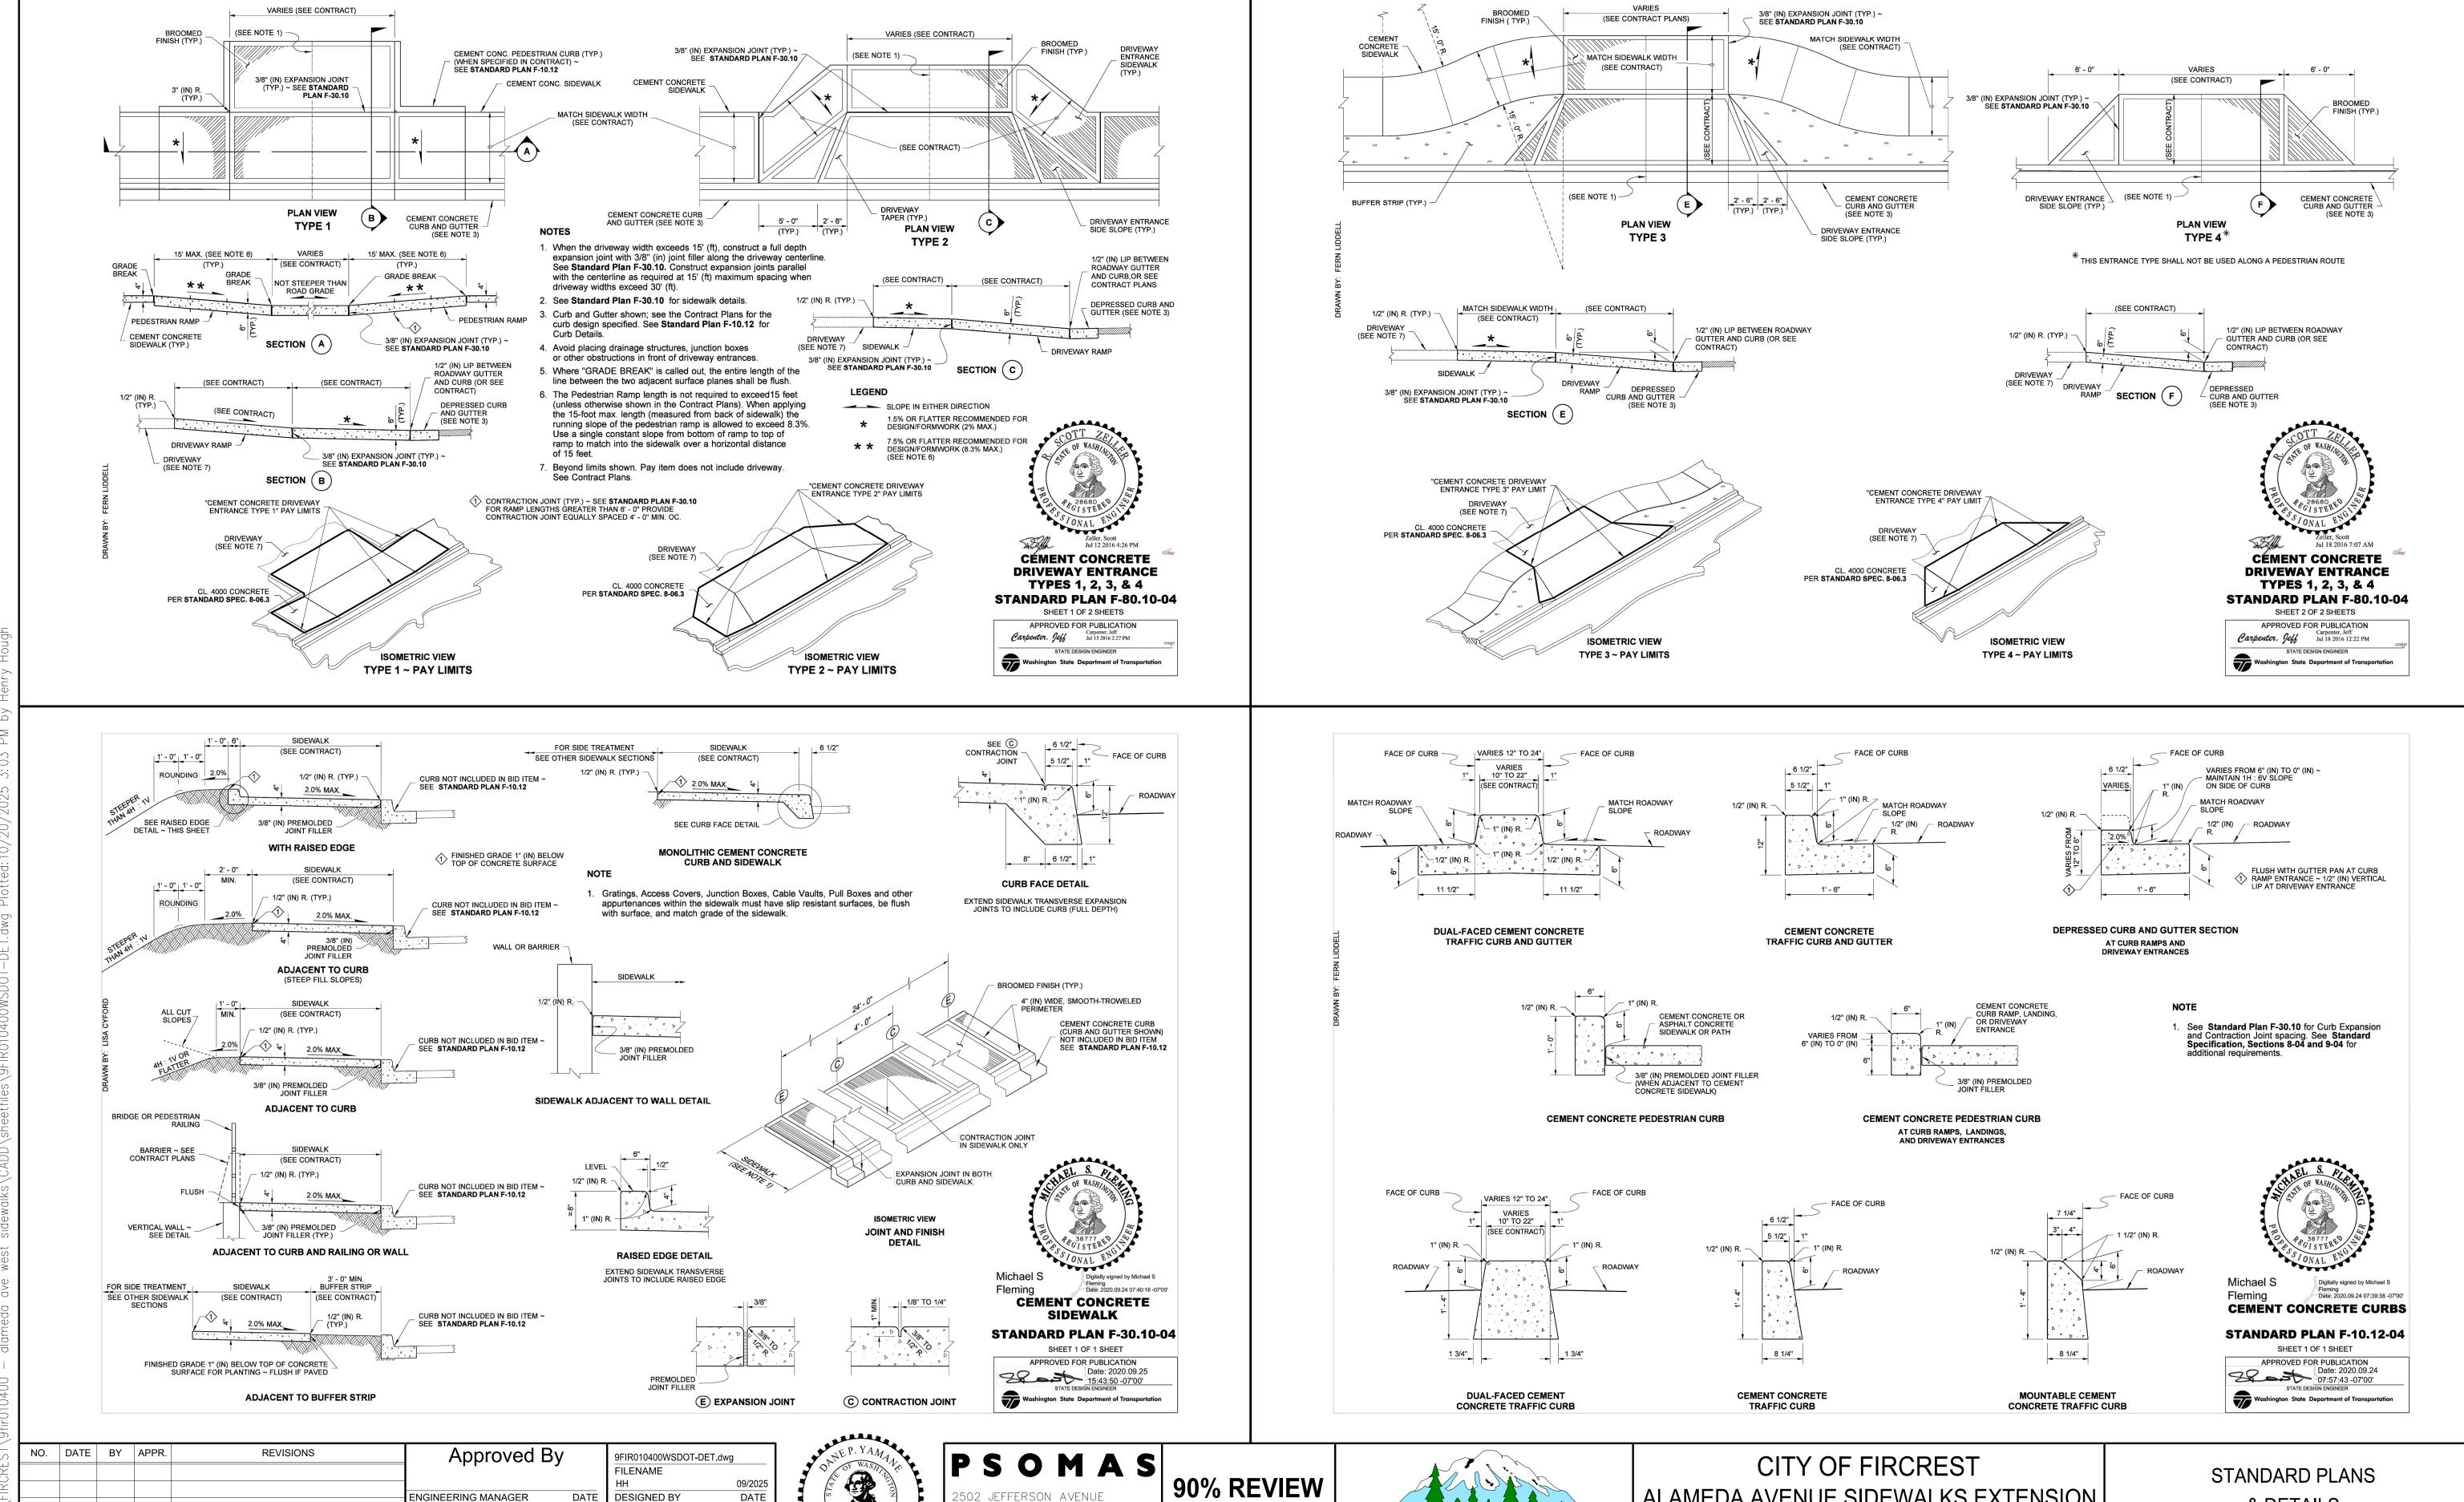

**SUBMITTAL** 

THE CITY OF FIRCREST

ALAMEDA AVENUE SIDEWALKS EXTENSION

CYPRESS POINT AVE TO EMERSON STREET

& DETAILS

9FIR010400

PROJ. No.

SHT \_\_8

of \_\_9

09/2025

DATE

09/2025

DATE

09/2025

DATE

ENGINEERING MANAGER

ROJECT MANAGER

ROJECT ENGINEER

DATE

DESIGNED BY

DRAWN BY

DATE | CHECKED BY


502 JEFFERSON AVENUE


ACOMA, WA 98402


253.627.0720

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**Product Number** 

**Design Features** 

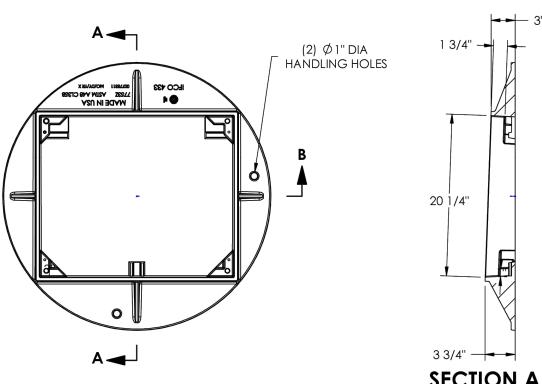Gray Iron (CL35B) -Design Load Heavy Duty -Open Área

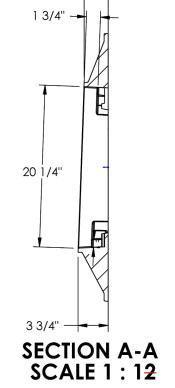-√ Designates Machined Surface

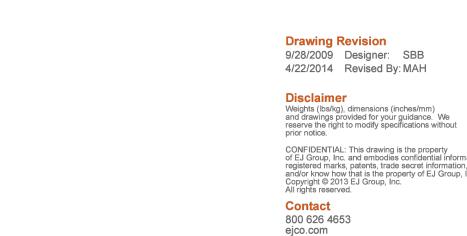
00775311

-Materials

-Coating Undipped

Certification -ASTM A48

-Country of Origin: USA

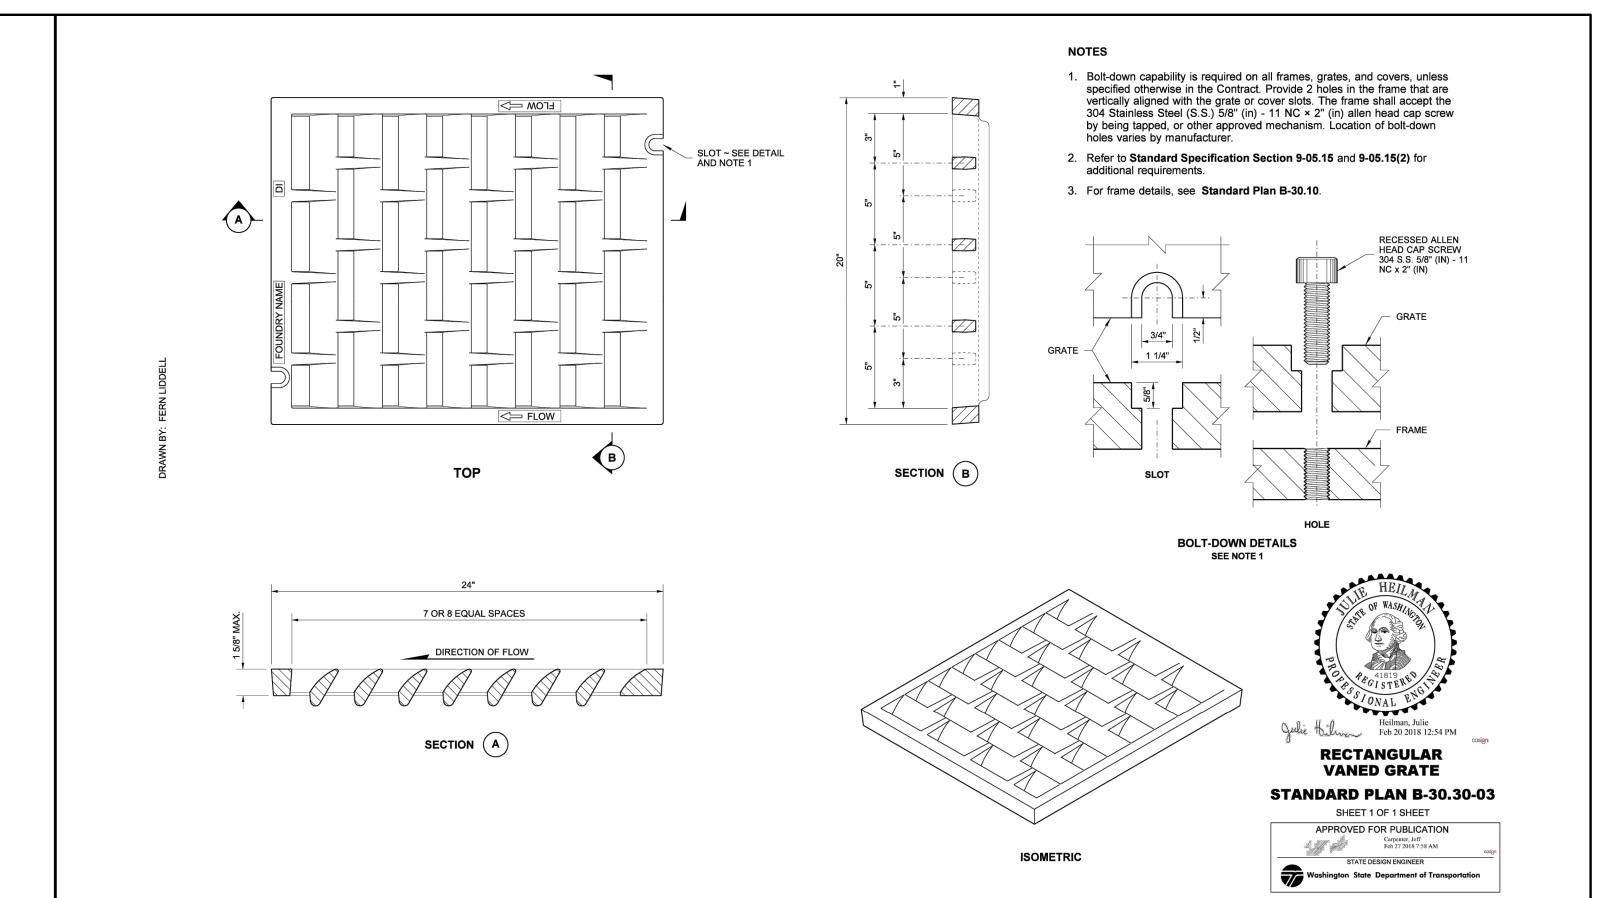

#### **APPENDIX A – Cluster Box Unit Installation Single Unit**

· Ø33 1/2" -

SECTION B-B SCALE 1:12

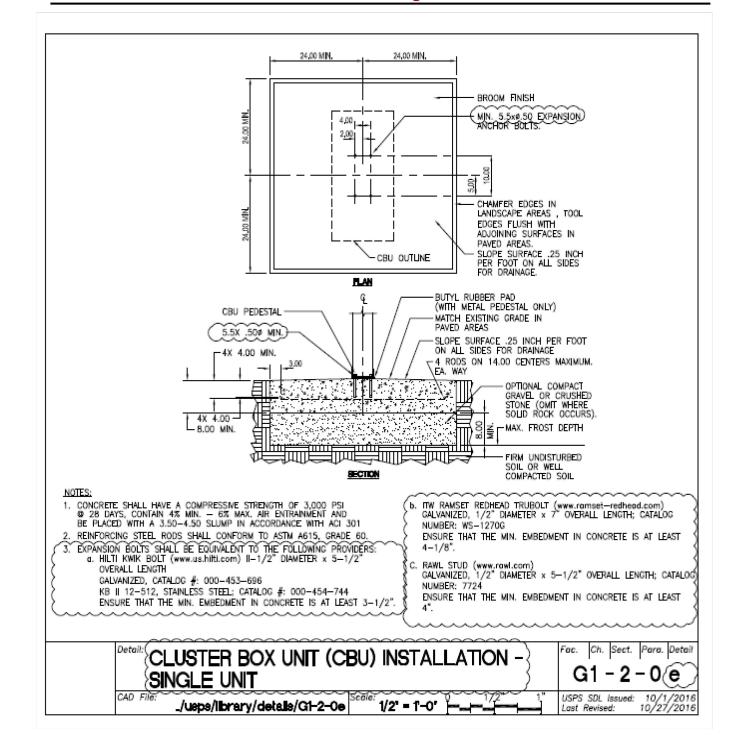



Figure 3B-1. Yellow Center Lines for Two-Lane, Two-Way Applications A – Two-lane, two-way marking with passing permitted in both directions Note: See Section 3B.11 for application of pavement markings through intersections or interchanges Legend → Direction of travel

Figure 9C-9. Shared Lane Marking 112 inches 72 inches ← 40 inches →

**MUTCD FIGURE 3B-1(A)** 

**MUTCD FIGURE 9C-9** 

Approved By NO. DATE BY APPR. REVISIONS 9FIR010400WSDOT-DET.dwg **FILENAME** 09/2025 DATE ENGINEERING MANAGER DATE DESIGNED BY 09/2025 DATE PROJECT MANAGER DRAWN BY 09/2025 DATE DATE CHECKED BY PROJECT ENGINEER

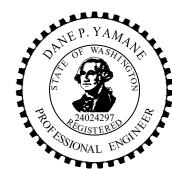



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CITY OF FIRCREST ALAMEDA AVENUE SIDEWALKS EXTENSION CYPRESS POINT AVE TO EMERSON STREET

STANDARD PLANS & DETAILS

SHT <u>9</u> of \_\_9 PROJ. No. 9FIR010400